GENERAL

- 1. ALL DRAWINGS SHALL BE READ IN CONJUNCTION WITH THE SPECIFICATION AND ANY OTHER WRITTEN INSTRUCTIONS ISSUED
- 2. WHERE APPROVAL IS REQUIRED, THIS SHALL BE OF THE SUPERINTENDENT OR HIS REPRESENTATIVE.
- ANY AMBIGUITY OR DISCREPANCY SHALL BE REFERRED FOR CLARIFICATION BEFORE WORK
- DIMENSIONS ARE IN PRESENTED MILLIMETERS WITH EQUIVALENT FOOT/INCH VALUE SHOWN IN BRACKETS.
- EXAMPLE: 1000mm [3'-3 \(\frac{3}{8}'' \)
- REFER TO THE DRAWING DIMENSIONS FOR SETTING OUT THE WORKS. HOWEVER, ALL EXISTING DIMENSIONS AND LEVELS ARE APPROXIMATE AND SHALL BE CONFIRMED BY THE CONTRACTOR ON SITE.
- 4. UNLESS NOTED OTHERWISE, ALL LEVELS ARE IN METRES [m]
- THE CONTRACTOR SHALL BE RESPONSIBLE FOR MAINTAINING THE STABILITY OF THE STRUCTURE UNTIL ITS COMPLETION AND SHALL ENSURE THAT NO PART OF THE STRUCTURE IS OVERSTRESSED DURING THE WORKS.
- WHERE STANDARDS ARE REFERRED TO, THEY SHALL BE THE LATEST EDITION.
- 7. PROPRIETARY ITEMS, PROPOSED BY THE CONTRACTOR, ARE TO BE REVIEWED AND APPROVED BY THE DESIGNING ENGINEER PRIOR TO USE.
- 8. THE CONTRACTOR SHALL BE RESPONSIBLE FOR SECURING WORK AREAS.
- 9. ALL DEMOLITION SHALL BE IN AN ACCEPTABLE MANNER UNDER THE OCCUPATIONAL HEALTH AND SAFETY REGULATIONS 2009. ALL SURPLUS MATERIAL SHALL BE DISPOSED OF OFF SITE IN A LEGAL MANNER.

CONCRETE

- 1. CONCRETE SHALL COMPLY WITH THE FOLLOWING SPECIFICATION:
- MINIMUM CONCRETE STRENGTH AT SERVICE F'c = 25 MPa [3600PSI]
- MINIMUM CEMENT CONTENT - MAXIMUM WATER/CEMENT RATIO

- $= 440 \text{ Kg/m}^3 [28 \text{ lb/ft}^3]$
- 2. CONCRETE MIX DESIGNS TO BE SUBMITTED TO THE ENGINEER FOR APPROVAL
- 3. NO ADDITIVES TO BE USED WITHOUT THE PRIOR APPROVAL OF THE ENGINEER.
- 4. CAST IN ITEMS WITH LESS THAN 25mm COVER TO ATMOSPHERE SHALL BE HOT DIPPED GALVANISED IN ACCORDANCE WITH ASTM A153.
- 5. ALL FORMWORK, SHORING AND RESHORING SHALL BE THE RESPONSIBILITY OF AND DESIGNED BY THE CONTRACTOR
- 4. CONCRETE SHALL BE TESTED FOR SLUMP ON SITE. THE TEST CYLINDERS SHALL BE TAKEN FOR 3 7 AND 28 DAY STRENGTHS.
- 5. CONCRETE STRENGTH AND SLUMP TO BE AS FOLLOWS

MIN. SPECIFIED 28 DAY STRENGTH	SLUMP
25 MPa	75mm ± 25mm
[3600PSI]	[3" ± 1"]

DESIGN

1. THE DESIGN OF RETAINING WALLS AS SHOWN IN THIS PACKAGE OF DRAWINGS IS BASED ON THE FOLLOWING PARAMETERS:

SOIL PROPERTIES

UNIT WEIGHT OF RETAINED

EAST OF THE RETAINING WALL

 $= 20 \text{ kN/m}^3$

 $= 10 \text{ kN/m}^2$

SHEAR RESISTANCE ANGLE OF RETAINED

LOADING

GROUND SURCHARGE

PASSIVE RESISTANCE USED IN DESIGN. CALCULATIONS ASSUME NO FUTURE EXCAVATION TO THE

2. TO MEET BS EN 1992-1-1:2004

- 3. A HIGH WATER TABLE HAS NOT BEEN CONSIDERED WITHIN THE DESIGN
- 4. THIS RETAINING WALL DRAWING PACKAGE SHOULD ONLY BE USED IF THE ABOVE CONDITIONS ARE CORRECT FOR THE PROPOSED PROJECT

SHEET PILING

- 1. THE CHOSEN SHEET PILING FOR THE PROJECT ARE FIBRE REINFORCED POLYMER (FRP) SUPERLOC SHEET PILES SERIES 1580 (SS860)
- 2. IF CHOSEN SHEET PILING IS UNAVAILABLE, THE DESIGNING ENGINEER IS TO BE CONSULTED AND DESIGN TO BE REVISED ACCORDINGLY
- 3. DUE TO THE SENSITIVE NATURE OF THE VULNERABLE DRY STONE WALL, HAMMER DRIVING OF SHEET PILING IS NOT PERMITTED.
- 4. THE USE OF A CRANE TO INSTALL SHEET PILING IS NOT PERMITTED DUE TO OVERHEAD UTILITIES.

EXCAVATION AND EARTHWORKS


- 1. FOUNDATIONS ARE TO BEAR ON UNDISTURBED AND SOUND GROUND/ROCK. BEARING MATERIAL IS TO REMAIN UNDISTURBED AND BE REVIEWED BY THE ENGINEER PRIOR TO POURING FOOTING.
- 2. ALL SHORING, SHEETING AND DE-WATERING SHALL BE THE RESPONSIBILITY OF THE CONTRACTOR
- 3. THE CONTRACTOR SHALL TAKE PRECAUTIONS TO PROTECT ALL EXISTING AND SURROUNDING **INFRASTRUCTURE**
- 4. ANY SOFT AREAS IN BEARING MATERIAL ARE TO BE REMOVED AND FILLED WITH MASS CONCRETE OF MINIMUM STRENGTH 25 MPa.
- 5. NO BACKFILLING UNTIL 7 DAYS AFTER LAST CONCRETE POUR
- 6. BACKFILL MATERIAL SHALL BE FREE FROM ORGANIC MATTER, CONSTRUCTION DEBRIS AND LARGE ROCKS.
- 7. BACKFILL MATERIAL SHALL BE WELL GRADED AND PLACED IN LAYERS NOT EXCEEDING 150mm (6")
- 8. BACKFILL MATERIAL TO BE COMPACTED EVERY 600mm (2')
- 9. EXISTING VEGETATION ROOTS WITHIN THE EXTENTS OF THE NEW RETAINING WALL TO BE CUT/REMOVED AND TREATED WITH ROOT KILLER.
- 10. IF UNEXPECTED MECHANICAL, ELECTRICAL OR STRUCTURAL ELEMENTS ARE ENCOUNTERED, THE CONTRACTOR SHALL SUBMIT DETAILS OF SUCH TO THE ENGINEER.
- 11. AN INVESTIGATION PHASE HAS BEEN INCLUDED FOR THE CONTRACTOR TO LOCATE AND IDENTIFY EXISTING UNDERGROUND UTILITIES WITHIN THE SITE EXTENTS. THE CONTRACTOR SHALL ENSURE THAT THE UTILITIES ARE SUPPORTED AND PROTECTED THROUGHOUT THE WORKS
- 12. DEMOLITION OF DRY STONE WALL IS TO BE DONE BY HAND AND/OR LIGHT MACHINERY.
- 13. ALL ROADS AND PUBLIC ACCESS ARE TO REMAIN OPEN AND UNOBSTRUCTED DURING INVESTIGATION WORKS.
- 14. THE UPPER ROAD IS TO BE MONITORED DURING DEMOLITION OF THE WALL. IF MOVEMENT OR SETTLEMENT IS SEEN, STOP WORKS AND MAKE AREA SAFE

REINFORCEMENT

- 1. WELDING OF REINFORCEMENT SHALL NOT BE PERMITTED UNLESS SHOWN ON THE STRUCTURAL DRAWINGS. IF SHOWN/PERMITTED, WELDS SHALL DEVELOP THE FULL STRENGTH OF THE REINFORCING ELEMENT
- 2. ALL REINFORCING STEEL TO HAVE A MINIMUM YIELD STRENGTH OF 410 MPa AND SHALL BE TYPE 2
- 3. ALL REINFORCING STEEL SHALL BE CLASS II GALVANISED IN ACCORDANCE WITH ASTM A767. TIE WIRE SHALL ALSO BE GALVANISED.
- 4. REINFORCEMENT SPACING NOT SHOWN SHALL BE TAKEN AS EQUAL
- 5. REINFORCING CHAIRS ARE TO BE CONCRETE AND AS SMALL AS PRACTICABLE. PROPRIETARY PLASTIC COVER SUPPORTS MAY BE USED WITH THE APPROVAL OF THE ENGINEER.
- 6. REINFORCING BARS SHOWN ON THESE DRAWINGS ARE DIAGRAMMATIC ONLY.
- 7. BARS SHOWN MAY REPRESENT MORE THAN ONE LENGTH AND/OR PROFILE.
- 8. BARS MAY NOT BE SHOWN IN TRUE POSITION FOR CLARITY. ALL HOOKS, BENDS AND COGS ARE STANDARD AND SHALL BE IN ACCORDANCE WITH ACI 318 UNLESS NOTED OTHERWISE
- 10. BARS SHALL NOT BE CUT NOR BENT ON SITE WITHOUT THE PRIOR APPROVAL OF THE ENGINEER. 11. BARS SHALL BE BENT COLD BY MACHINE OR OTHER APPROVED MEANS PRODUCING A GRADUAL AND EVEN MOTION. BARS INCORRECTLY BENT SHALL NOT BE RE-BENT AND INCORPORATED IN THE WORKS AND NO REINFORCEMENT SHALL BE BENT WHEN IN POSITION IN THE WORKS. WHETHER OR NOT IT IS
- PARTIALLY EMBEDDED IN HARDENED CONCRETE. 12. CONTRACTOR TO PROVIDE 24 HOURS NOTICE FOR THE INSPECTION OF ALL REINFORCING PRIOR TO POURING CONCRETE.
- 10. LAP LENGTHS SHALL BE AS TABULATED (SHOWN BELOW) UNLESS SHOWN OTHERWISE ON THE DRAWINGS.

MINIMUM ALLOWABLE LAP LENGTHS						
BAR DIAMETER	MIN LAP LENGTH					
T10	460mm [18"]					
T12	600mm [24"]					
T16	760mm [30"]					
T20	900mm [36"]					
T25	1500mm [60'']					

ALTERNATIVE BAR SIZES						
METRIC BAR SIZE (mm)	IMPERIAL EQUIVALENT (")	FORMER IMPERIAL DESIGNATION				
T10	3/8"	#3				
T12	1/2"	#4				
T16	5/8"	#5				
T20	3/4"	#6				
T25	1"	#8				

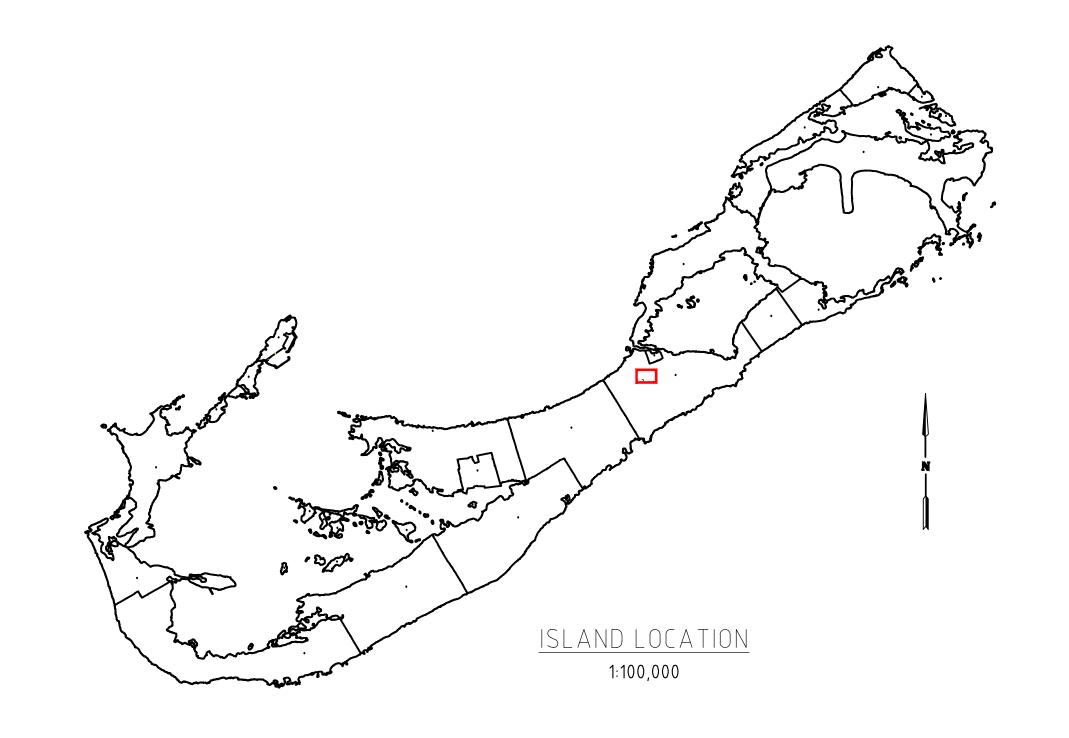



SCALE 1:500 AT ORIGINAL SIZE

THE MINISTRY OF PUBLIC WORKS

P.O. Box HM525 Hamilton HMCX Bermuda Phone: (441) 295-5151

DEPARTMENT OF WORKS AND ENGINEERING

Fax: (441) 295-5658

AMENDMENTS: BY APP DATE NO | REVISION A FOR TENDER CF AK 01/12/23 REVISED TO SHEET PILING FOLLOWING LAND SURVEY | CF | AK | 29/02/24 SCALE: AS SHOWN AT ANSI D SURVEY PREPARED BY: DATE: DESIGN PREPARED BY: DATE: 29/11/23 C.FRASER CHECKED BY: DATE: 01/12/23 A.KENNY DRAWING PREPARED BY: DATE: 29/11/23 C.FRASER CHECKED BY: DATE: 01/12/23 A.KENNY APPROVED BY: DATE: 01/12/23 A.KENNY PROJECT NUMBER: 42-782B-100

ISSUED FOR: FOR TENDER


BRIDLE HILL DRY STONE WALL

MIDDLE ROAD SMITHS SHEET TITLE:

PROJECT NAME:

LOCATION PLAN & GENERAL NOTES

SHEET NUMBER: REVISION S000

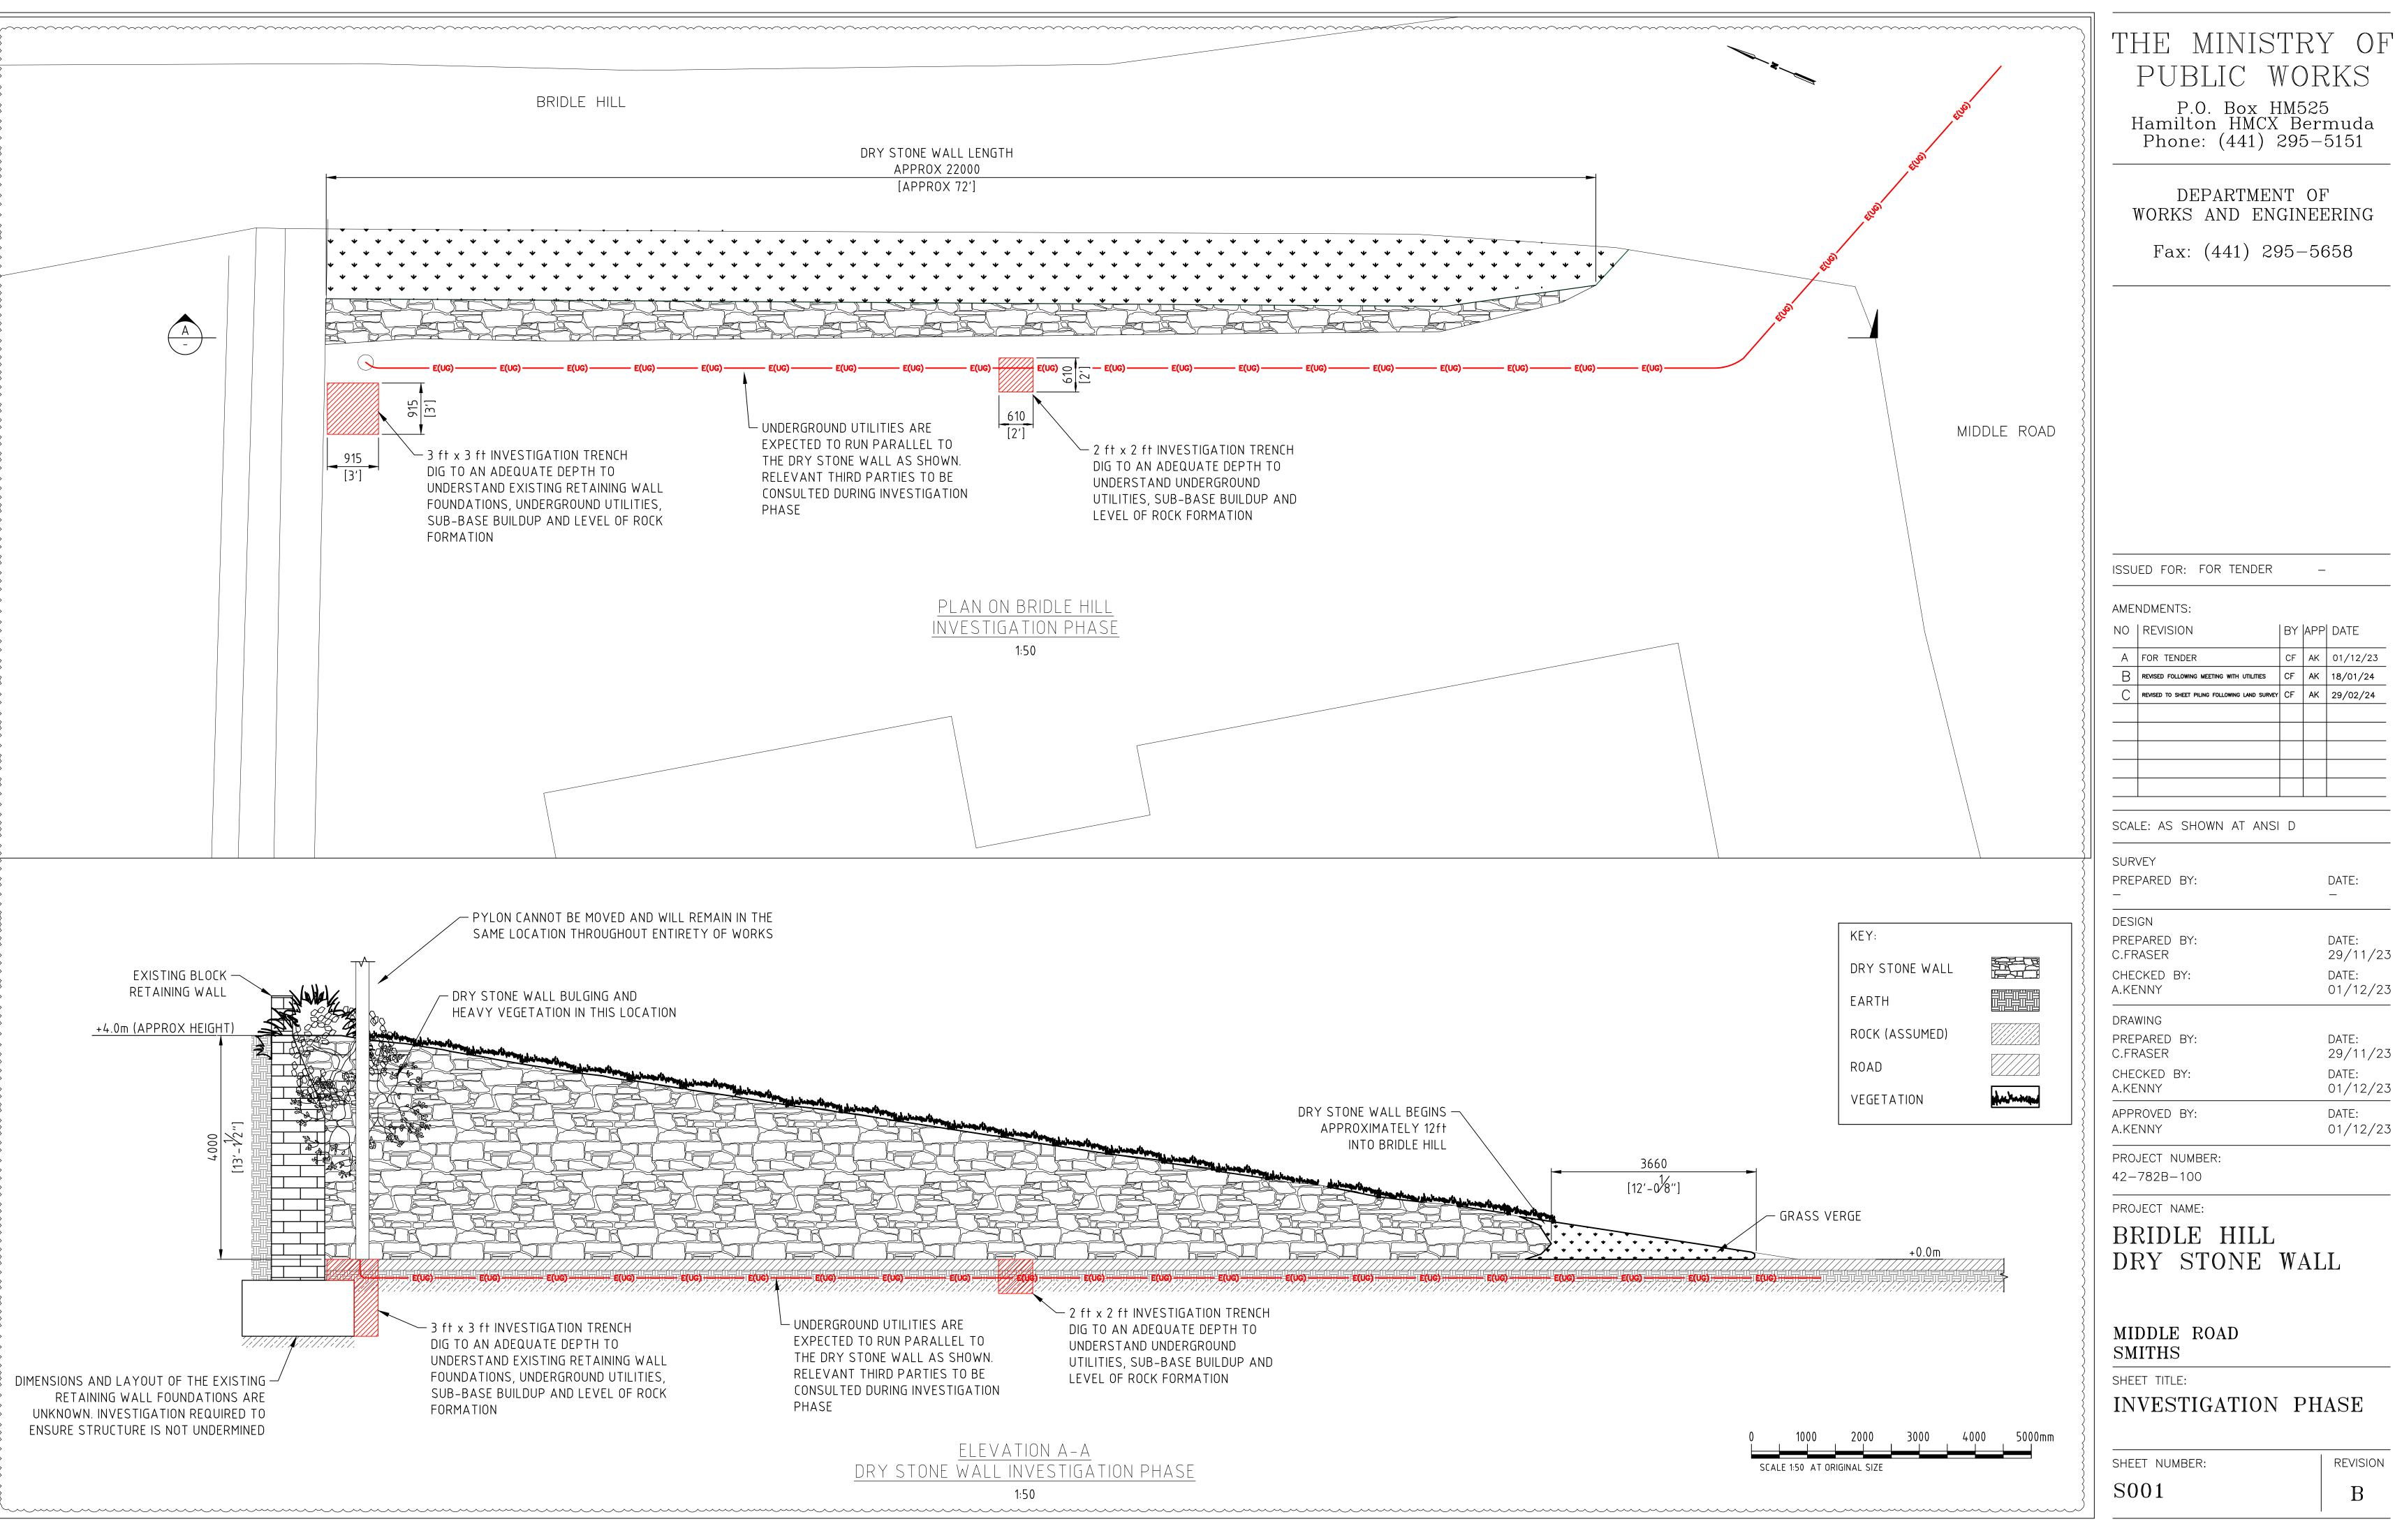


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DEPARTMENT OF WORKS AND ENGINEERING

CF | AK | 01/12/23 REVISED FOLLOWING MEETING WITH UTILITIES | CF | AK | 18/01/24 REVISED TO SHEET PILING FOLLOWING LAND SURVEY CF AK 29/02/24

DRY STONE WALL


REVISION

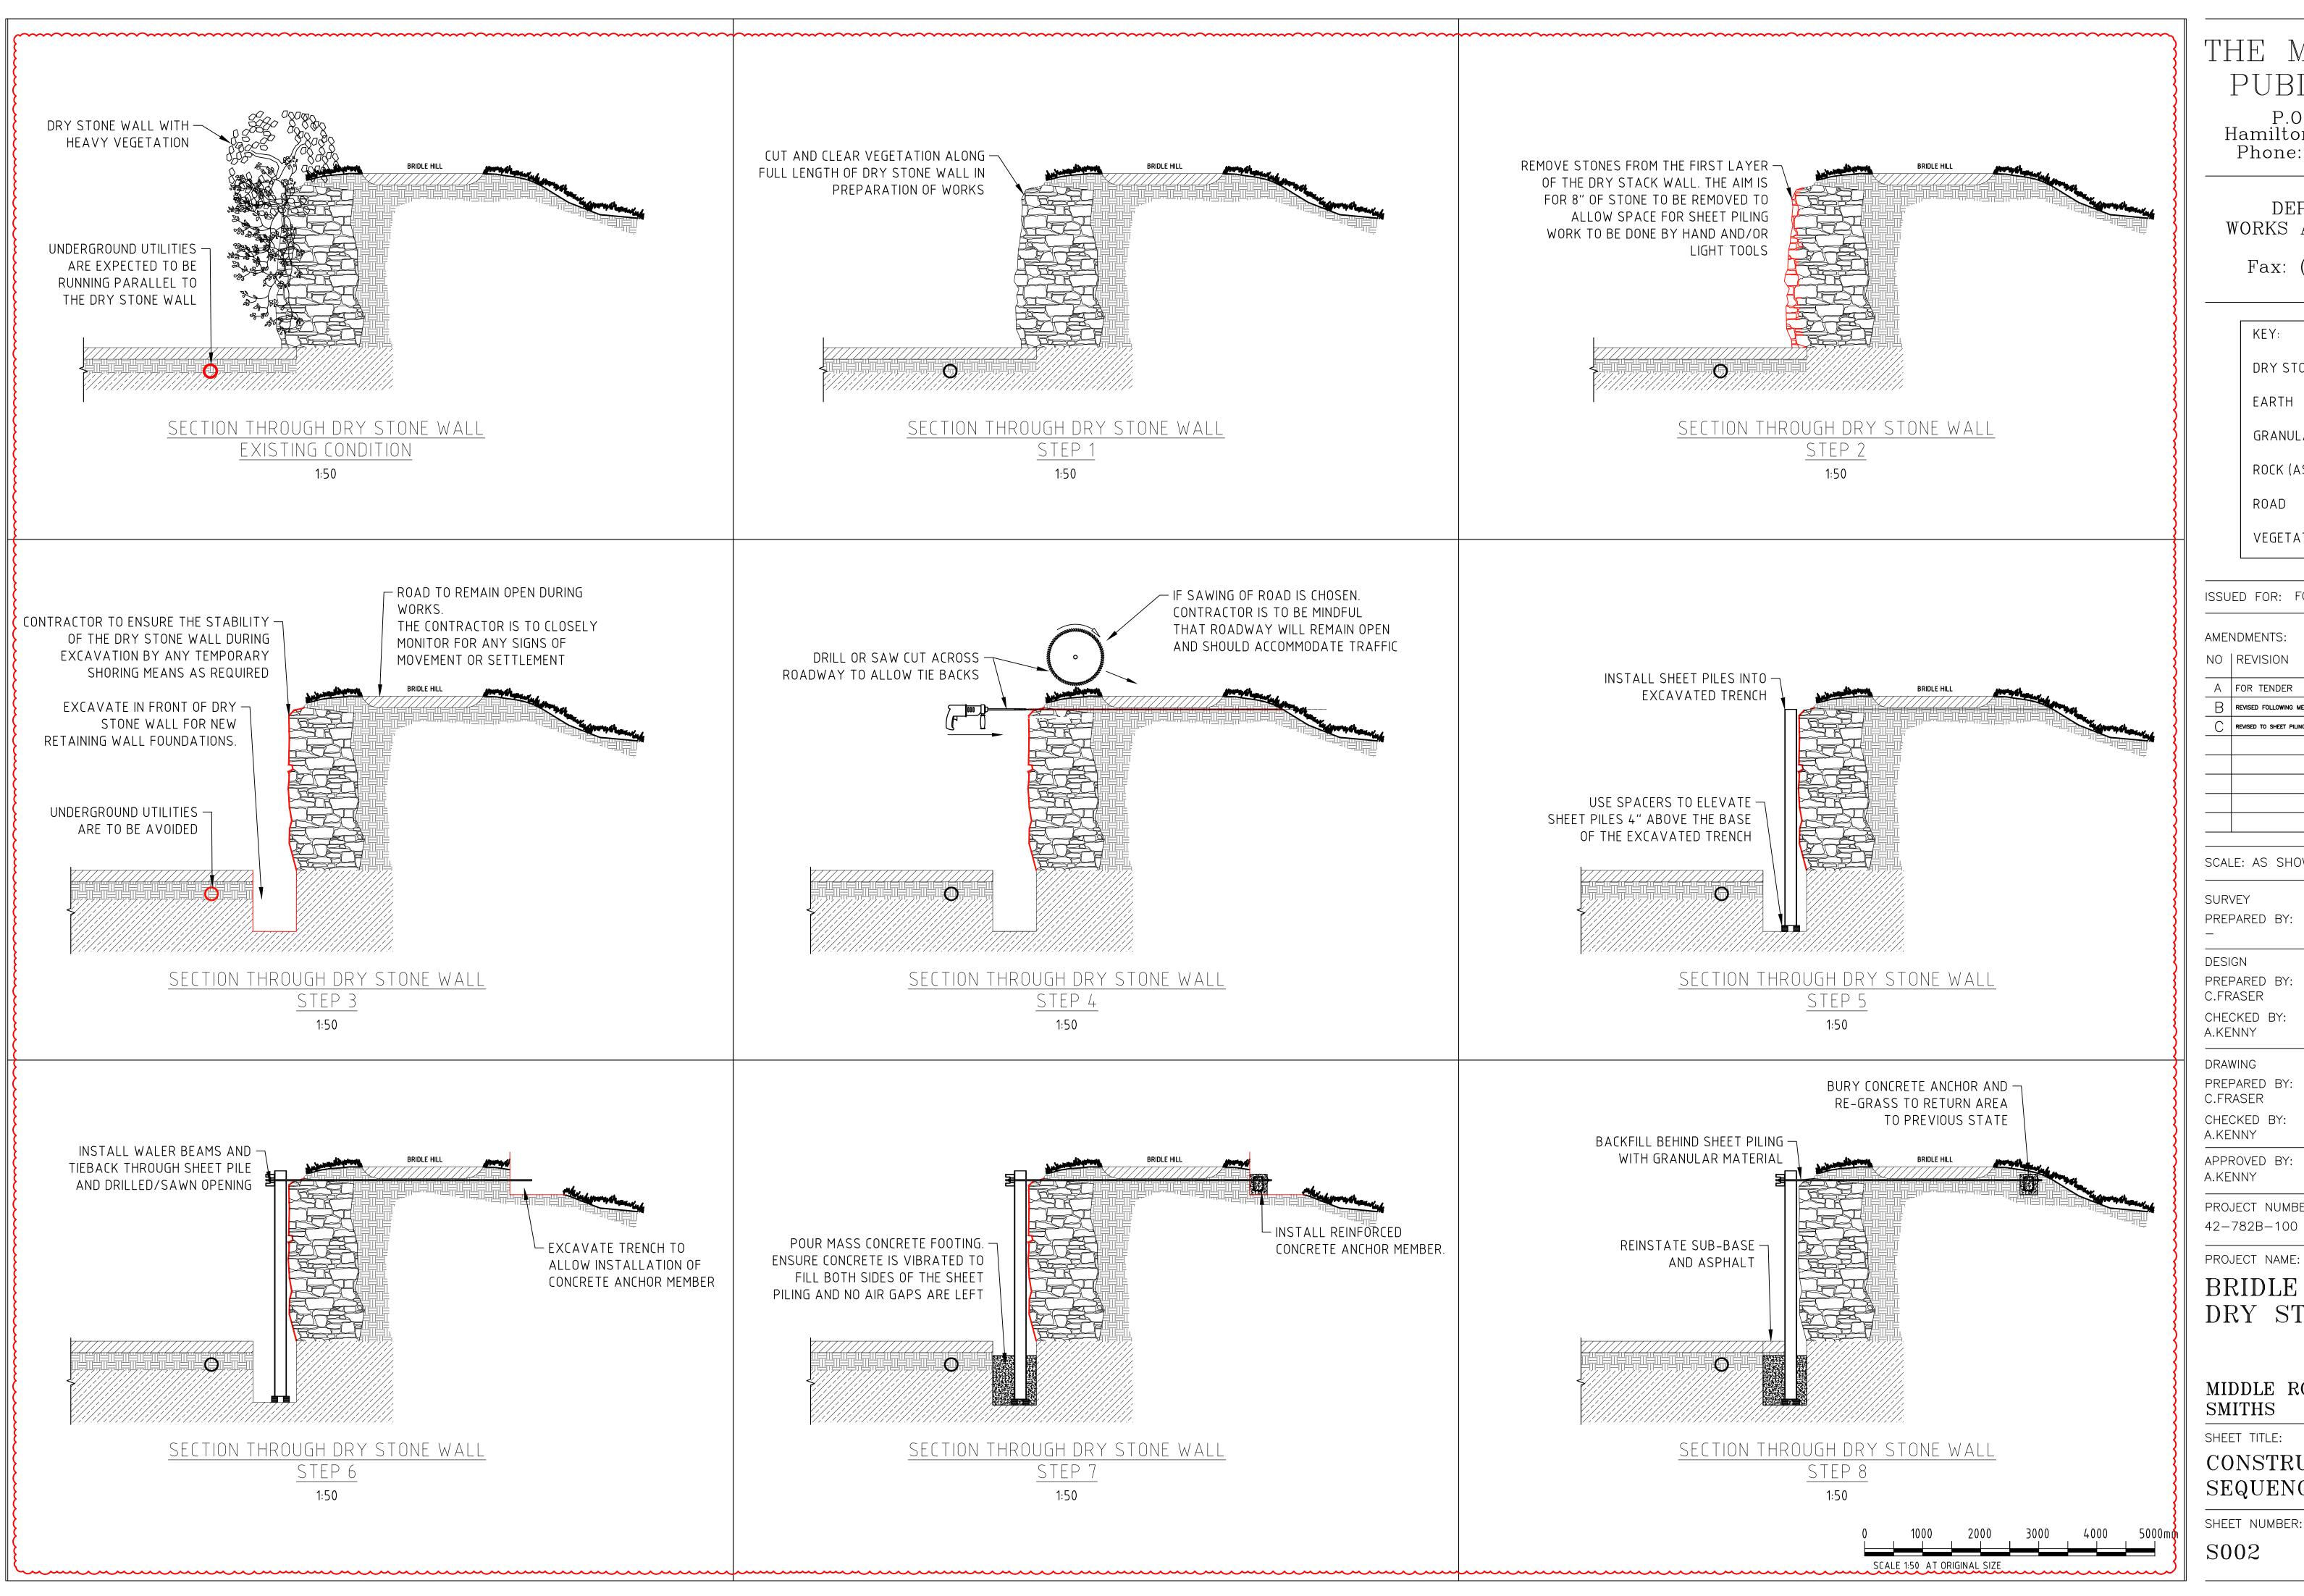

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ISSU	ED FOR: FOR TENDER		_	
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В	REVISED FOLLOWING MEETING WITH UTILITIES	CF	AK	18/01/24
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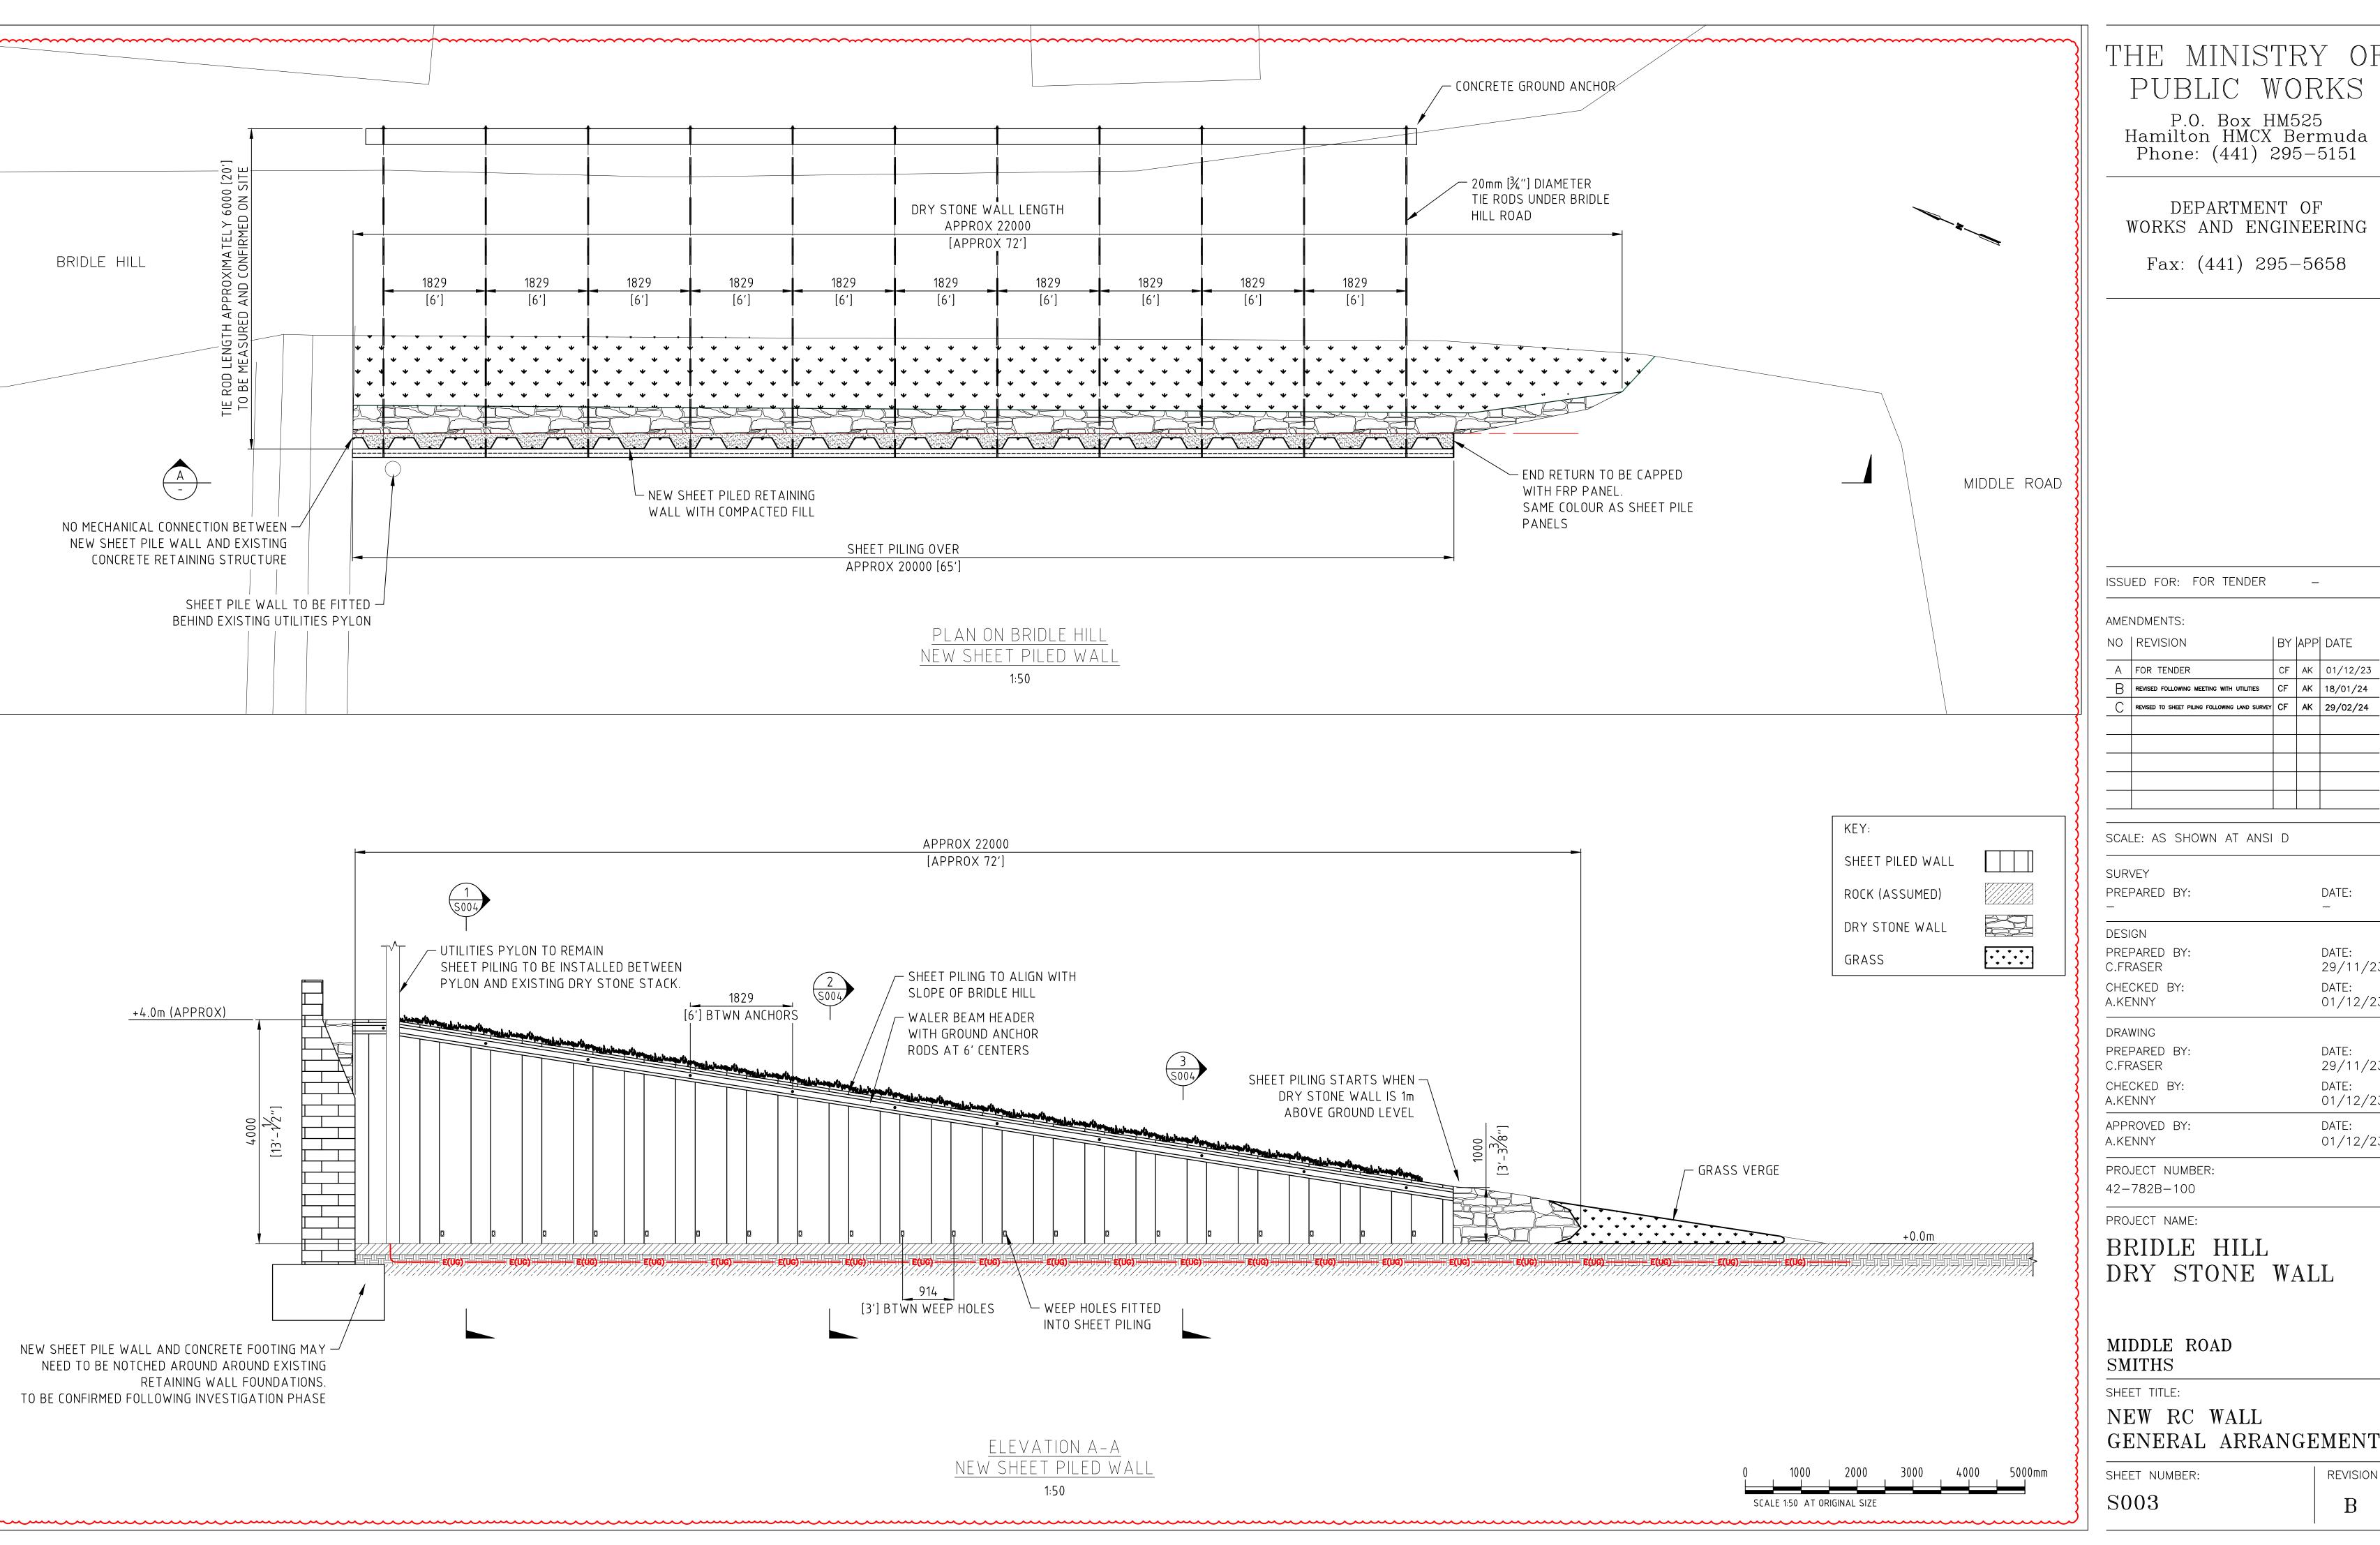
PROJECT NUMBER: 42-782B-100

BRIDLE HILL DRY STONE WALL

MIDDLE ROAD

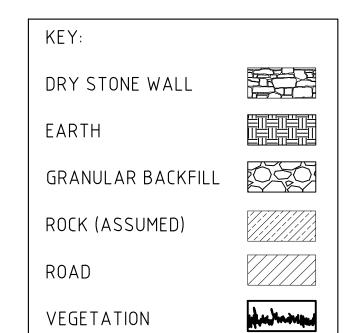CONSTRUCTION SEQUENCE

SHEET NUMBER: REVISION



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BY APP DATE CF AK 01/12/23

REVISED FOLLOWING MEETING WITH UTILITIES | CF | AK | 18/01/24 REVISED TO SHEET PILING FOLLOWING LAND SURVEY CF AK 29/02/24

DATE:

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29/11/23

DATE: 01/12/23

29/11/23

REVISION

PREPARED BY: C.FRASER

CHECKED BY:

01/12/23 DATE: 01/12/23

42-782B-100


PROJECT NAME:

BRIDLE HILL DRY STONE WALL

MIDDLE ROAD SMITHS

NEW RC WALL

SHEET NUMBER:

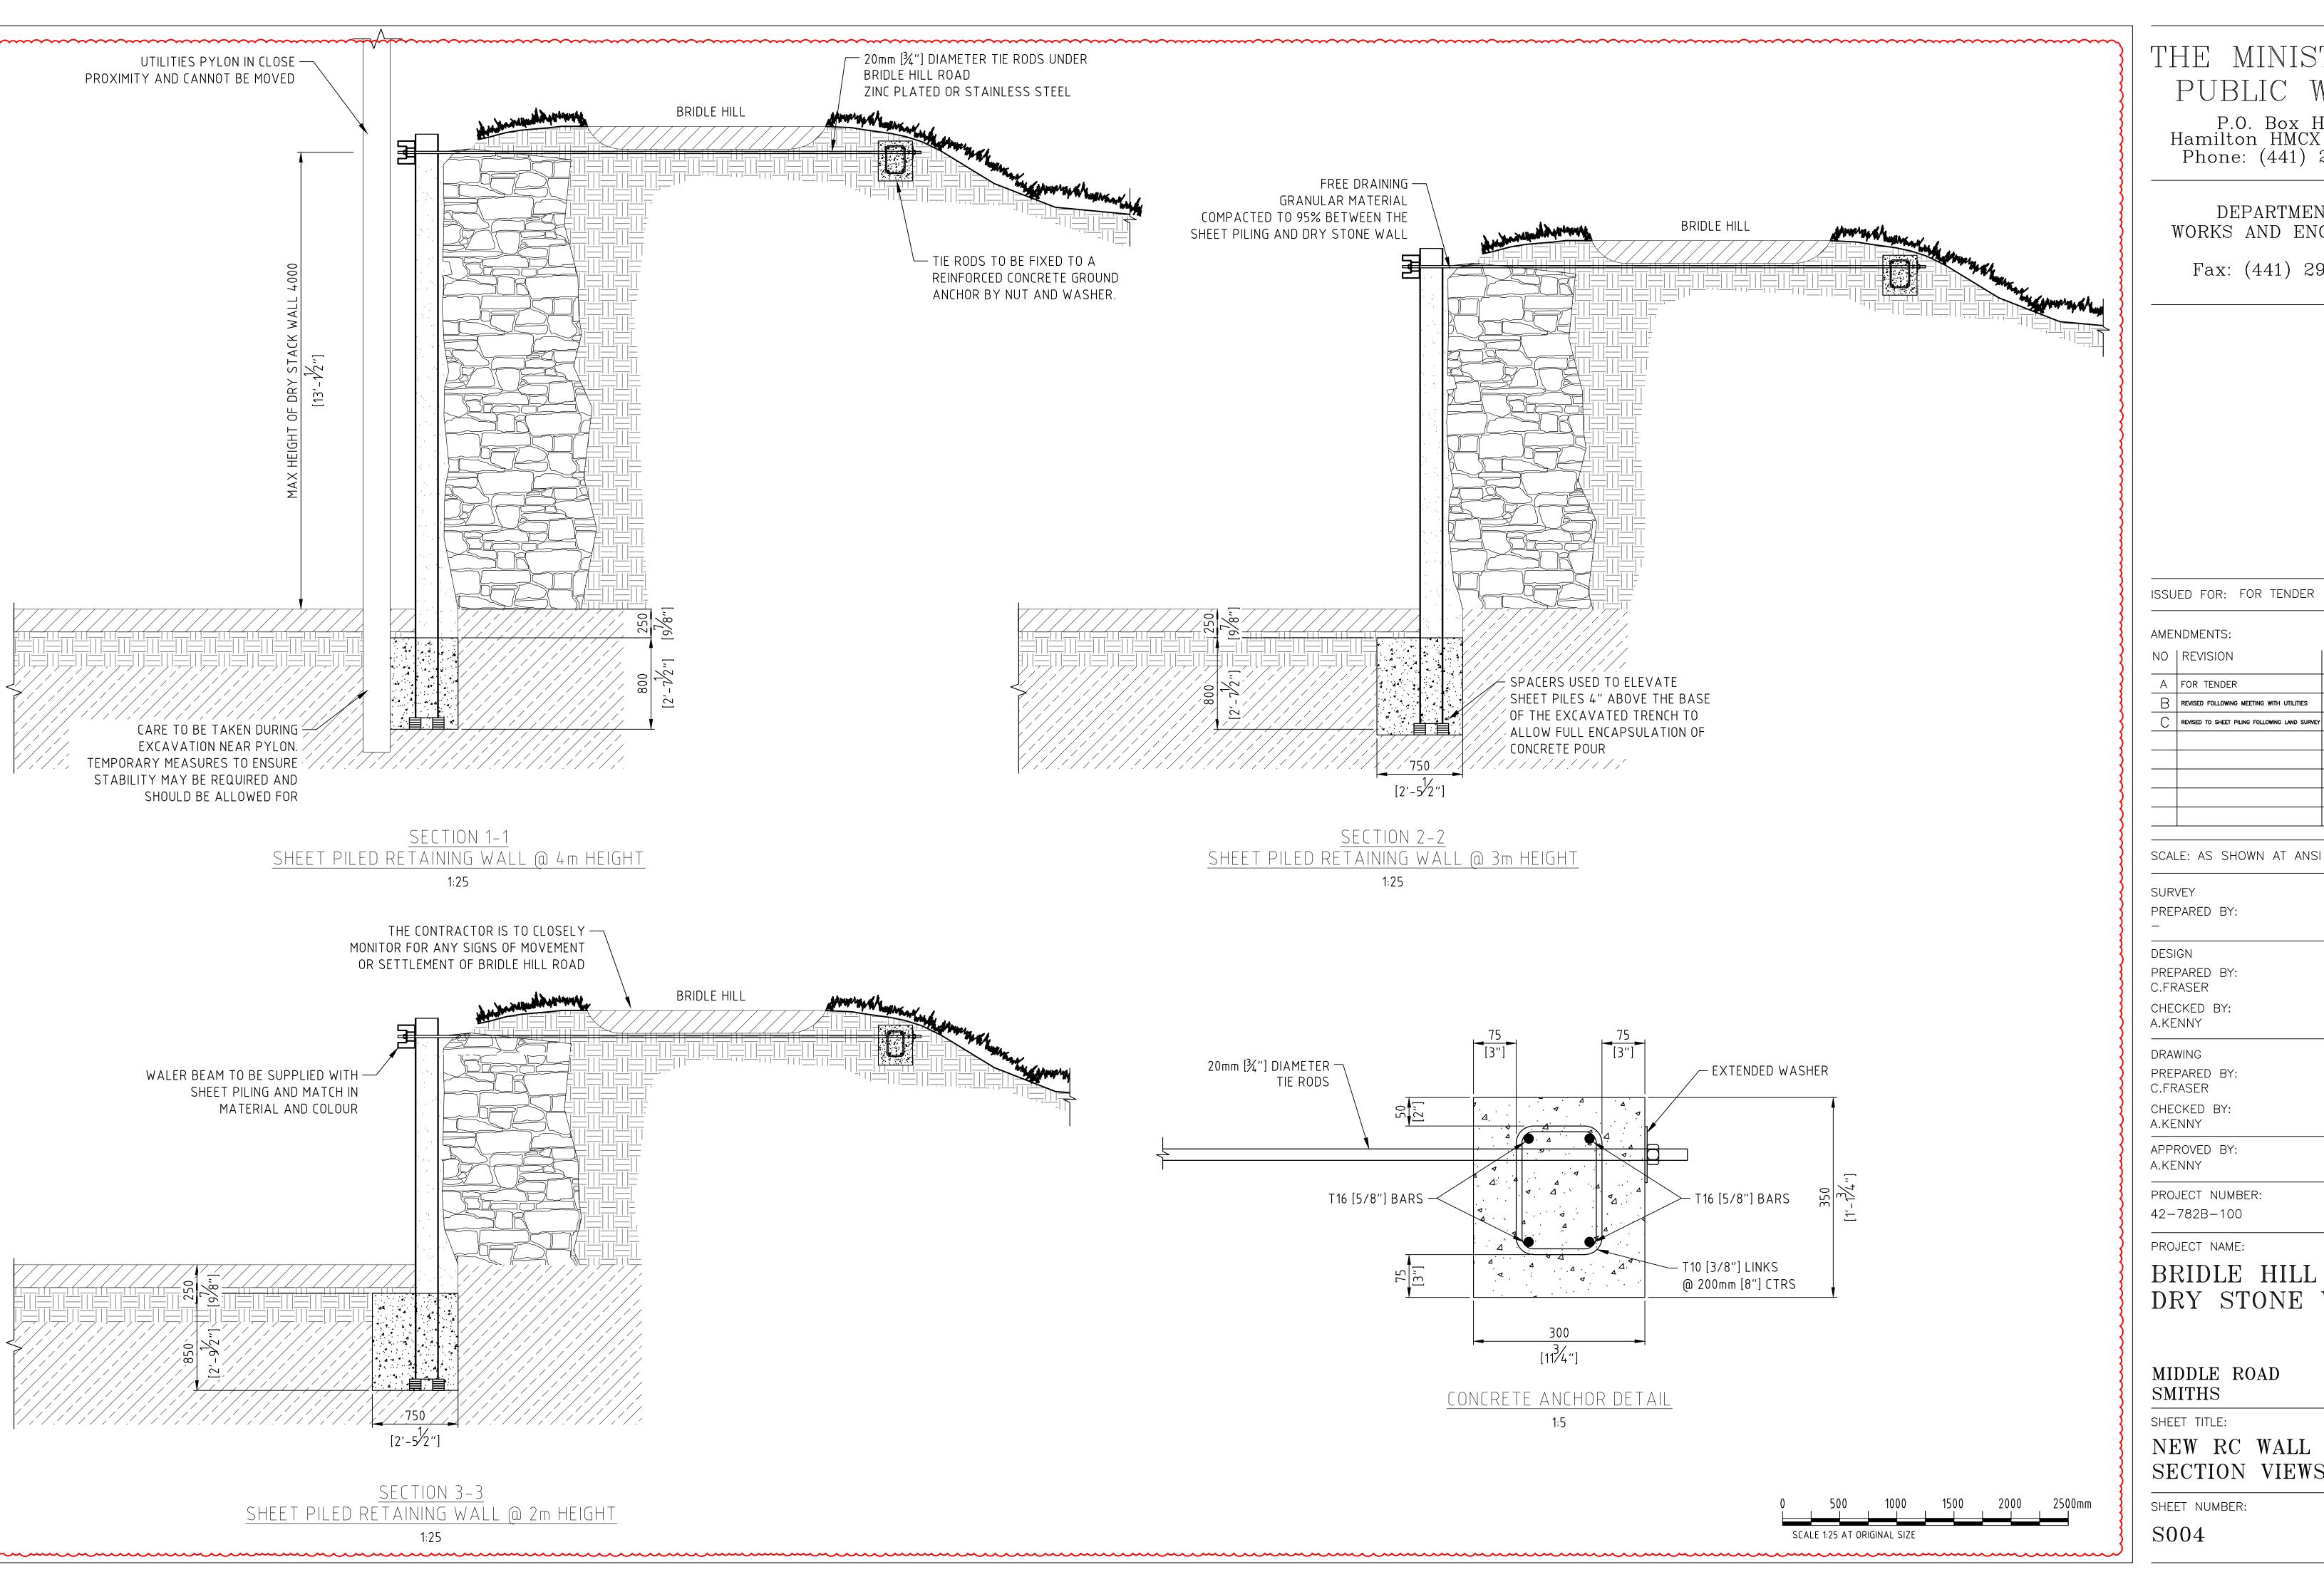

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Fax: (441) 295-5658

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REVISION

PREPARED BY:

C.FRASER CHECKED BY:

DATE: 01/12/23

DRAWING

PREPARED BY: C.FRASER CHECKED BY:

PROJECT NUMBER:

PROJECT NAME:

BRIDLE HILL DRY STONE WALL

MIDDLE ROAD SMITHS

SHEET TITLE:

NEW RC WALL SECTION VIEWS

SHEET NUMBER: S004